

06-17-ST-267 JOHN BARROW RD STREETSCAPE

(JOHN BARROW RD/KANIS RD INTERSECTION & JOHN BARROW RD - CALS LIBRARY SIDEWALK) 60% SUBMITTAL

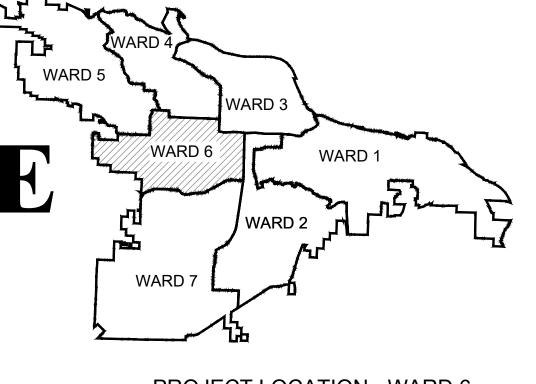


PROJECT LOCATION - WARD 6

JOHN BARROW STREETSCAPE			
Sheet Number	Sheet Title		
C0.0	COVER SHEET		
C1.1	GN LEGEND AND QUANTITIES SHEET		
C2.1	DEMOLITION AND EROSION PLAN		
C2.2	DEMOLITION AND EROSION PLAN		
C3.1	JOHN BARROW RD & KANIS RD INTERSECTION - SITE PLAN		
C3.2	JOHN BARROW RD CALS LIBRARY BOARDWALK - SITE PLAN		
C3.3	JOHN BARROW RD CALS LIBRARY BOARDWALK - ENLARGED SITE PLAN		
C3.4	JOHN BARROW RD CALS LIBRARY BOARDWALK - ENLARGED SITE PLAN		
C4.1	DETAIL SHEET		

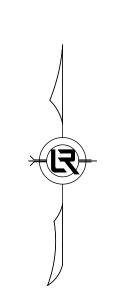



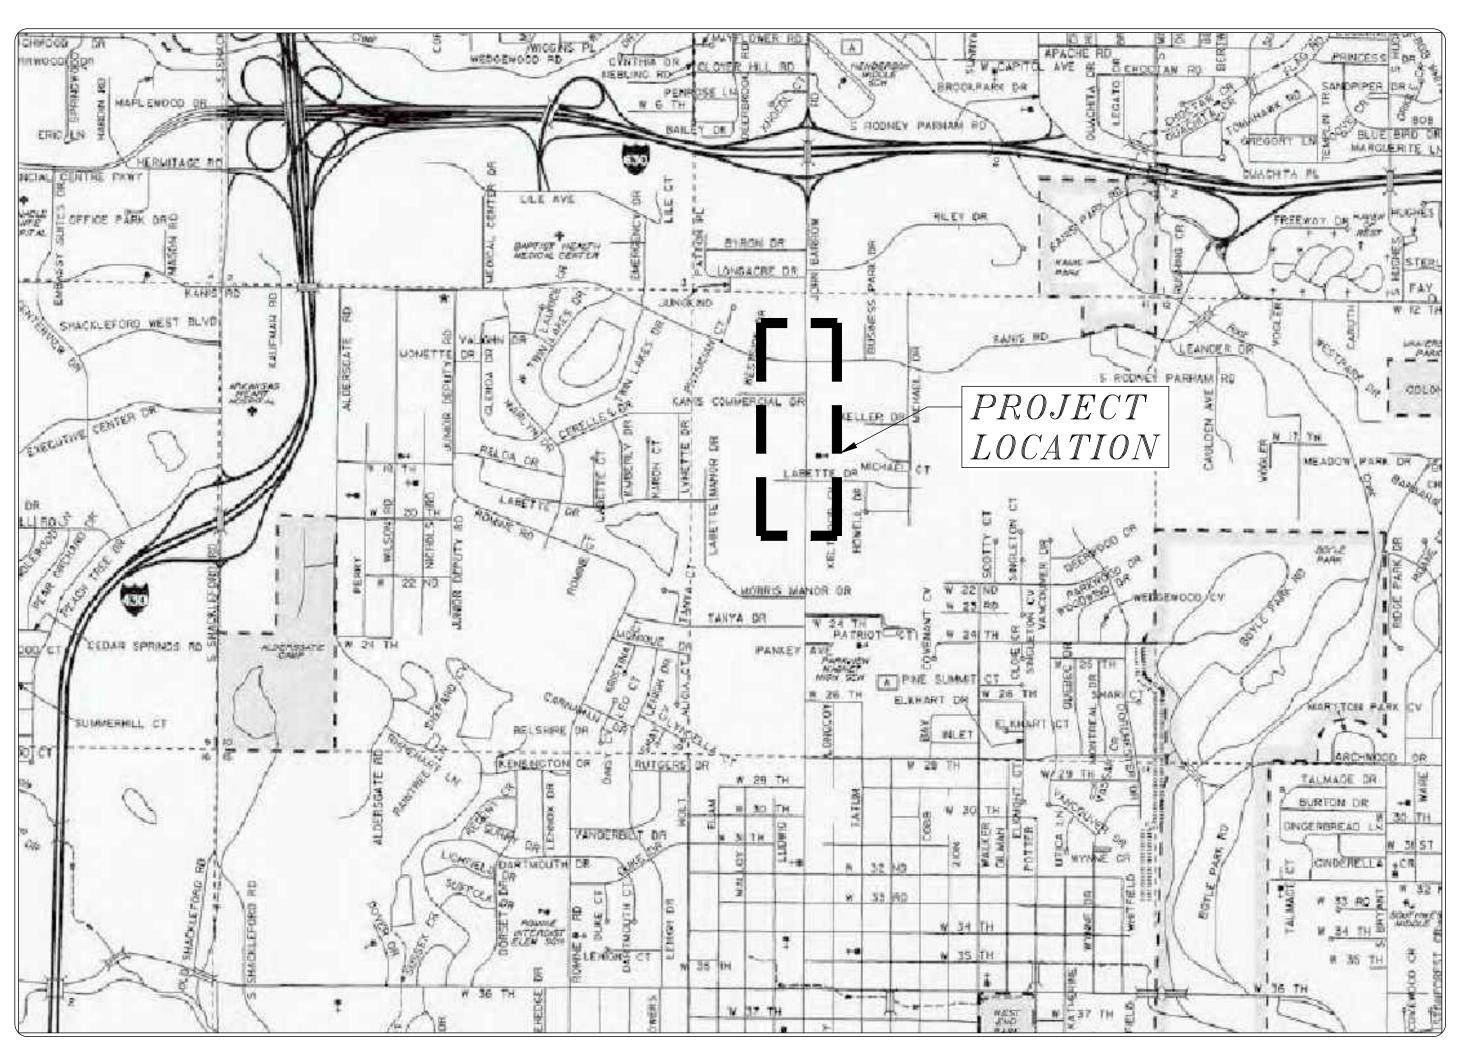



2019-2021 **BOND PROGRAM** DEPARTMENT OF PUBLIC WORKS CIVIL ENGINEERING 701 WEST MARKHAM STREET LITTLE ROCK, ARKANSAS 72201



60% SUBMITTAL REVIEW ONLY

DRAWN BY LCJ **DESIGNED** SBH **CHECKED** SBH DATE 02-07-20 SCALE **NO SCALE** PROJECT NO. 06-17-ST-267 SHEET NO.

C0.0

	06-17-ST-267			
	JOHN BARROW RD AND KANIS RD INTERSECTION - MATERIAL QUANTITIES			
ITEM #	DESCRIPTION	UNIT	QTY	
2.01	SITE PREPARATION	LS	1	
3.40	TOPSOIL	CY	30	
4.01	AGGREGATE BASE COURSE (CLASS 7)	TON	100	
8.03	CONCRETE CURB AND GUTTER (CLASS 3)	LF	473	
9.04	CONCRETE SIDEWALK (4" THICK)	SF	2948	
11.20	REINFORCED CONCRETE RETAINING WALL	CY	213	
14.01	SOLID SODDING- BERMUDA	SY	930	
16.01	MAINTENANCE OF TRAFFIC	LS	1	
18.50	ACCESS RAMP W TRUNCATED DOMES	SF	532	
604.01	HYDROBLASTING FOR PAVEMENT MARKING REMOVAL	SF	252	
706.00	RELOCATION OF TRAFFIC SIGNAL HEAD	EA	3	
707.00	COUNTDOWN PED SIG HEAD, LED	EA	5	
708.00	TRAFFIC SIGNAL CABLE (5C / 14A.W.G.)	LF	400	
711.00	CONCRETE PULL BOX (TYPE 2 HD)	EA	4	
715.00	TRAFFIC SIGNAL PED. POLE W/ FND	EA	4	
711.01	TYPE 2 PULL BOX	EA	4	
719.24W	THERMOPLASTIC PAVEMENT MARKING WHITE (12")	LF	157	
SP	STAMPED AND INTEGRAL COLORED CONCRETE	SF	2056	
SP	CONCRETE BAND- CROSSWALKS	SF	575	
SP	NEIGHBORHOOD SIGN	LS	1	
SP	TREES- 2" CAL.	EA	0	
SP	SITE FURNISHINGS- Bench w/dividers	EA	1	
SP	SITE FURNISHINGS- Trash Receptacle	EA	1	
SP	LIGHTING	EA	15	
SP	ELECTRICAL	LS	1	
19.01	FINAL CLEANUP (AS DIRECTED BY ENGINEER)	LS	1	
	UTILITY RELOCATION	BY OTHERS		

	06-17-ST-267		
	JOHN BARROW RD CALS SIDEWALK - MATERIAL QUAN	TITIES	
TEM #	DESCRIPTION	UNIT	QTY
2.01	SITE PREPARATION	LS	1
3.40	TOPSOIL	CY	100
9.04	CONCRETE SIDEWALK (4" THICK)	SF	915
14.01	SOLID SODDING- BERMUDA	SY	300
16.01	MAINTENANCE OF TRAFFIC	LS	1
24.06	SILT FENCE -TYPE A (SFA)	LF	370
SP	BOARDWALK	SF	995
SP	SITE FURNISHINGS- Bench w/dividers	EA	1
SP	TRASH RECEPTACLE	EA	1
SP	LIGHTING	EA	7
SP	ELECTRICAL	LS	1
19.01	FINAL CLEANUP (AS DIRECTED BY ENGINEER)	LS	1

EXISTING

LAIG	11101		
IDON, DOD	O ID	PROPOSED CONTOUR	
IRON ROD PK NAIL	○ IR ○ PK	PROPOSED SPOT ELEVATION	
R.R. SPIKE	O RR(Sp)		
CONC. MONUMENT	□ CM	PROPOSED SPOT CURB ELEVATIO	
WATER VALVE	— ⊠ WV	STORM SEWER - PIPE	
WATER METER	□ WM	STORM SEWER - MITERED END S	
FIRE HYDRANT	Ϋ́FН	STORM SEWER — GRATE INLET	
GAS METER	☑ GM	STORM SEWER - GRATE INCET	
GAS VALVE	⊗ GV	STORM SEWER - JUNCTION BOX	
CLEAN-OUT	○ CO		
GUARD POST (BOLLARD)	• GP	STORM SEWER - FLARED END SE	
SIGN POST BENCHMARK			
DENCHMARK		STORM SEWER — HEADWALL	
STORM SEWER MANHOLE	D		
		STORM SEWER — SINGLE WING	
SANITARY SEWER MANHOLE	(S)	CTORM CEWER DOUBLE WING	
TELEPHONE MANHOLE	(T)	STORM SEWER — DOUBLE WING	
TELEPHONE MANHOLE		STORM SEWER — AREA INLET	
ELECTRIC MANHOLE	(E)		
		GRADE BREAK LINE	
TELEPHONE BOX	T	HIGH POINT	
ELECTRIC BOX CABLE BOX	E	LOW POINT CUT LINE	
UTILITY POLE		FILL LINE	
GUY WIRE	\in	SANITARY SEWER PIPE	
LIGHT POLE	\$	CANITARY CEWER MANITOLE	
POST OR POLE (TYPE AS NOTED	(a)	SANITARY SEWER MANHOLE	
MAILBOX		PROPOSED CURB	
DECIDUOUS TREE	50	PROPOSED CONCRETE	
EVERGREEN/CONIFEROUS TREE	<u> </u>	CONSTRUCTION - ENTRANCE/EXI	
DUCH		CHECK DAM	
BUSH	كرس	DIVERSION BERM	
PROPERTY LINE -			
SETBACK LINE -		DOWNDRAIN STRUCTURE — TEMPO	
EASEMENT LINE -		ROCK DAM	
CURB = = = = = = = = = = = = = = = = = = =		SEDIMENT BARRIER — SILT FENCE	
	— OE — — OE —	SEDIMENT BANNEN - SIETTENOL	
	— OT — OT —	SEDIMENT BARRIER — GRAVEL RI	
OVERHEAD CABLE -	oc oc	CEDIMENT DADDIED DI COM 1	
UNDERGROUND TELEPHONE -	UGT	SEDIMENT BARRIER — BLOCK & (
UNDERGROUND ELECTRIC -	UGE	SEDIMENT BARRIER - BLOCK	
UNDERGROUND CABLE -	UGC-		
WATER LINE -	8"W — 8"SS — 8"S	TEMPORARY SEDIMENT BASIN	
SEWER LINE - GAS LINE -	——————————————————————————————————————	SILT FENCE - TYPE A	
	24" CMP/RCP/DIP	SILT FENCE — TYPE B	
STORM SEWER/CULVERT		SILT FENCE — TYPE C	
EDGE OF WOODS			
CONTOUR LINE -	650	STODM DRAIN OUTLET DROTECTIO	

PROPOSED

	/
PROPOSED CONTOUR	25
PROPOSED SPOT ELEVATION	(25.00)
PROPOSED SPOT CURB ELEVATION	(25.50) (25.00)
STORM SEWER — PIPE STORM SEWER — MITERED END SECTION	
STORM SEWER - GRATE INLET	
STORM SEWER - JUNCTION BOX	
STORM SEWER - FLARED END SECTION	
STORM SEWER - HEADWALL	
STORM SEWER - SINGLE WING	
STORM SEWER - DOUBLE WING	
STORM SEWER - AREA INLET	
GRADE BREAK LINE	
HIGH POINT LOW POINT	HP LP
CUT LINE	— C — — F —
FILL LINE SANITARY SEWER PIPE	—— SAN——
SANITARY SEWER MANHOLE	S
PROPOSED CURB	
CONSTRUCTION - ENTRANCE/EXIT	CO
CHECK DAM	CD
DIVERSION BERM	DI
DOWNDRAIN STRUCTURE - TEMPORARY	DN
ROCK DAM	RD
SEDIMENT BARRIER — SILT FENCE	(SD1)
SEDIMENT BARRIER — GRAVEL RING	SD2
SEDIMENT BARRIER - BLOCK & GRAVEL	SD3
SEDIMENT BARRIER - BLOCK	SD4)
TEMPORARY SEDIMENT BASIN	(SB1)
SILT FENCE - TYPE A	(SFA)
SILT FENCE - TYPE B	SFB
SILT FENCE - TYPE C	SFC
STORM DRAIN OUTLET PROTECTION	ST
SURFACE ROUGHENING	SU
DISTURBED AREA STABILIZATION -TEMPORARY STABILIZATION	TION TS1
DISTURBED AREA STABILIZATION -TEMPORARY GRASSING	TS2
DISTURBED AREA STABILIZATION -PERMANENT GRASSING	TS3
MATTING/BLANKETS	Mb

CONSTRUCTION LIMITS



LILLE ROCK, ARRAINSAS

TMENT OF PUBLIC WORKS

60% SUBMITTAL REVIEW ONLY

DRAWN BY
LCJ
DESIGNED
SBH
CHECKED
SBH
DATE
02-07-20
SCALE
NO SCALE
PROJECT NO.
06-17-ST-267

SHEET NO.

C1.1



_ _ _ _ _

DEMOLITION AND EROSION PLAN

DEMOLITION GENERAL NOTES

- 1. ALL WORK SHALL BE CONFINED TO LIMITS OF CONSTRUCTION SHOWN ON PLANS.
- 2. CONTRACTOR SHALL COORDINATE AND BE IN COMPLIANCE WITH ALL STATE AND LOCAL MUNICIPALITIES AS WARRANTED. CONTRACTOR SHALL NOTIFY OWNER AND LANDSCAPE ARCHITECT PRIOR TO START OF PROJECT.
- 3. ANY DISCREPANCIES FOUND BETWEEN THE DRAWINGS AND SPECIFICATIONS AND EXISTING SITE CONDITIONS OR ANY INCONSISTENCIES OR AMBIGUITIES IN DRAWINGS OR SPECIFICATIONS SHALL BE IMMEDIATELY REPORTED TO THE OWNER AND LANDSCAPE ARCHITECT, IN WRITING, WHO SHALL PROMPTLY ADDRESS SUCH INCONSISTENCIES OR AMBIGUITIES. WORK DONE BY THE CONTRACTOR AFTER HIS DISCOVERY OF SUCH DISCREPANCIES, INCONSISTENCIES, OR AMBIGUITIES SHALL BE DONE AT THE CONTRACTOR'S RISK.
- 4. DEVIATION FROM THESE PLANS AND NOTES WITHOUT THE PRIOR CONSENT OF THE OWNER, HIS/ HER REPRESENTATIVE, OR THE LANDSCAPE ARCHITECT MAY BE CAUSE FOR THE WORK TO BE DESIGNATED UNACCEPTABLE.
- 5. THE CONTRACTOR SHALL IMMEDIATELY REPORT TO THE OWNER AND LANDSCAPE ARCHITECT ANY UNFORESEEN OR ADVERSE CONDITIONS DISCOVERED DURING DEMOLITION OPERATIONS.
- 6. ALL TRENCHES AND/OR VOIDS CREATED BY THE REMOVAL OF EXISTING STRUCTURES & SITE ELEMENTS SHALL BE BACKFILLED PER LOCAL AND STATE REGULATIONS.
- 7. THE LOCATION AND SIZE OF KNOWN EXISTING ABOVE GROUND UTILITIES ARE NOT SHOWN ON THE SURVEY. THE CONTRACTOR IS RESPONSIBLE FOR HORIZONTALLY AND VERTICALLY LOCATING AND PROTECTING ALL PUBLIC AND PRIVATE UTILITIES WHICH LIE IN OR ARE ADJACENT TO THE CONSTRUCTION SITE. AT LEAST 48 HOURS PRIOR TO ANY DEMOLITION, GRADING, OR CONSTRUCTION ACTIVITY CALL ARKANSAS 811 AND COORDINATE UTILITY WORK WITH PULASKI COUNTY FOR COMPLIANCE WITH LOCAL CODES AND ORDINANCES.

1. REFER TO SITE PLAN SHEETS C3.1 FOR ADDITIONAL INFORMATION.

2. ALL BUSINESSES AND RESIDENCES TO REMAIN OPEN, OPERABLE

BARRIERS AND DIRECTIONAL SIGNAGE TO BE INSTALLED AS NEEDED

TOPSOIL AND LANDSCAPE MAY BE INSTALLED AT ONCE THROUGHOUT

TO ASSURE SAFE VEHICULAR AND PEDESTRIAN ACCESS.

3. CONTRACTOR TO COMPLETE ONE BLOCK AT A TIME FROM DEMOLITION THROUGH INSTALLATION OF CURB AND SIDEWALKS.

4. ALL UNDERGROUND UTILITIES TO REMAIN UNLESS NOTED

5. ALL UTILITIES, VALVES, METERS, FIRE HYDRANTS, THAT FALL INSIDE THE PROPOSED STREETSCAPE PROJECT ARE TO BE FLUSH

THE UTILITIES WITH 'ONE-CALL' AND THE CITY OF LITTLE ROCK.

7. PROVIDE 36" ACCESSIBLE ROUTE AROUND SIGNAL POLES.

8. REMOVE EXISTING CROSSWALK BARS AND STOP BARS

6. CONTRACTOR IS RESPONSIBLE FOR COORDINATING MARKING OF

CONTACT CITY FOR REVIEW PRIOR TO INSTALLATION OF SIDEWALKS /

- 8. THE CONTRACTOR SHALL PROTECT ALL EXISTING POWER POLES, MANHOLES, TELEPHONE RISERS, WATER VALVES, POND WALL, ETC., DURING ALL CONSTRUCTION PHASES, UNLESS NOTED OTHERWISE. THE CONTRACTOR SHALL REPAIR, AT HIS OWN EXPENSE, ANY
- EXISTING UTILITIES DAMAGED DURING CONSTRUCTION. 9. CONTRACTOR IS RESPONSIBLE FOR VERIFYING AND/OR OBTAINING ALL REQUIRED PERMITS AND APPROVALS PRIOR TO
- COMMENCING ANY PROJECT WORK. 10. ALL DEMOLITION DEBRIS AND OTHER EXCESS MATERIAL SHALL BE HAULED OFF-SITE AS DIRECTED BY THE OWNER AND PROPERLY
- 11. THE CONTRACTOR SHALL COORDINATE AND BE RESPONSIBLE FOR THE STAGING AND REMOVAL OF ALL DEMOLITION ITEMS.
- 12. THE CONTRACTOR SHALL BE RESPONSIBLE FOR REPAIRING ANY DAMAGE RESULTING FROM CONSTRUCTION ACTIVITY TO EXISTING ELEMENTS THAT ARE TO REMAIN.

DISPOSED OF IN A LEGAL MATTER, UNLESS OTHERWISE NOTED.

EROSION NOTES

2. ANY ACCIDENTAL RELEASE OF SEDIMENT FROM THE SITE SHALL

- PROVIDE SILT FENCE EROSION CONTROL, IF NECESSARY.
- AND ACCESSIBLE THROUGHOUT CONSTRUCTION. TEMPORARY WALKS, BE CLEANED UP BY THE CONTRACTOR.
 - 3. PRIOR TO COMPLETION OF THE PROJECT, CONTRACTOR SHALL CLEAN STREET GUTTERS WITHIN SCOPE OF WORK.
 - 4. EROSION CONTROL MEASURES SHALL BE PROVIDED BY THE CONTRACTOR. CONTRACTOR TO PROVIDE LOCATION OF EROSION CONTROL METHODS FOR OWNER'S APPROVAL. PRIOR TO PROJECT COMMENCEMENT.

LEGEND

NOTES

PROJECT.

OTHERWISE ON THESE PLANS.

WITH THE PROPOSED FINISHED GRADE.





REMOVE SIDEWALK AND DRIVEWAY (CONCRETE)



REMOVE EXISTING NEIGHBORHOOD SIGN

REMOVE CURB & GUTTER

60% SUBMITTAL REVIEW ONLY

REVISIONS

ARKANSAS

ROCK,

OF

CITY

SC

OSION PLAN RD INTERSECTION

DRAWN BY LCJ **DESIGNED** SBH **CHECKED** SBH DATE 02-07-20 SCALE SEE PLAN PROJECT NO. 06-17-ST-267

SHEET NO.

GRAPHIC SCALE SCALE: 1" = 40'-0"

NOTE: ABOVE SCALE REPRESENTS A PRINTED 11" X 17" SHEET SIZE.

DEMOLITION GENERAL NOTES

- 1. ALL WORK SHALL BE CONFINED TO LIMITS OF CONSTRUCTION
- 2. CONTRACTOR SHALL COORDINATE AND BE IN COMPLIANCE WITH ALL STATE AND LOCAL MUNICIPALITIES AS WARRANTED. CONTRACTOR SHALL NOTIFY OWNER AND LANDSCAPE ARCHITECT PRIOR TO START OF PROJECT.
- 3. ANY DISCREPANCIES FOUND BETWEEN THE DRAWINGS AND SPECIFICATIONS AND EXISTING SITE CONDITIONS OR ANY INCONSISTENCIES OR AMBIGUITIES IN DRAWINGS OR SPECIFICATIONS 10. ALL DEMOLITION DEBRIS AND OTHER EXCESS MATERIAL SHALL SHALL BE IMMEDIATELY REPORTED TO THE OWNER AND LANDSCAPE BE HAULED OFF-SITE AS DIRECTED BY THE OWNER AND PROPERLY ARCHITECT, IN WRITING, WHO SHALL PROMPTLY ADDRESS SUCH INCONSISTENCIES OR AMBIGUITIES. WORK DONE BY THE CONTRACTOR AFTER HIS DISCOVERY OF SUCH DISCREPANCIES, INCONSISTENCIES, OR AMBIGUITIES SHALL BE DONE AT THE CONTRACTOR'S RISK.
- 4. DEVIATION FROM THESE PLANS AND NOTES WITHOUT THE PRIOR CONSENT OF THE OWNER, HIS/ HER REPRESENTATIVE, OR THE LANDSCAPE ARCHITECT MAY BE CAUSE FOR THE WORK TO BE DESIGNATED UNACCEPTABLE.
- 5. THE CONTRACTOR SHALL IMMEDIATELY REPORT TO THE OWNER AND LANDSCAPE ARCHITECT ANY UNFORESEEN OR ADVERSE CONDITIONS DISCOVERED DURING DEMOLITION OPERATIONS.
- 6. ALL TRENCHES AND/OR VOIDS CREATED BY THE REMOVAL OF EXISTING STRUCTURES & SITE ELEMENTS SHALL BE BACKFILLED PER LOCAL AND STATE REGULATIONS.
- 7. THE LOCATION AND SIZE OF KNOWN EXISTING ABOVE GROUND UTILITIES ARE NOT SHOWN ON THE SURVEY. THE CONTRACTOR IS RESPONSIBLE FOR HORIZONTALLY AND VERTICALLY LOCATING AND PROTECTING ALL PUBLIC AND PRIVATE UTILITIES WHICH LIE IN OR ARE ADJACENT TO THE CONSTRUCTION SITE. AT LEAST 48 HOURS PRIOR TO ANY DEMOLITION, GRADING, OR CONSTRUCTION ACTIVITY CALL ARKANSAS 811 AND COORDINATE UTILITY WORK WITH PULASKI COUNTY FOR COMPLIANCE WITH LOCAL CODES AND ORDINANCES.

- DURING ALL CONSTRUCTION PHASES, UNLESS NOTED OTHERWISE. THE CONTRACTOR SHALL REPAIR, AT HIS OWN EXPENSE, ANY EXISTING UTILITIES DAMAGED DURING CONSTRUCTION.
- 9. CONTRACTOR IS RESPONSIBLE FOR VERIFYING AND/OR OBTAINING ALL REQUIRED PERMITS AND APPROVALS PRIOR TO COMMENCING ANY PROJECT WORK.
- DISPOSED OF IN A LEGAL MATTER, UNLESS OTHERWISE NOTED.
- 11. THE CONTRACTOR SHALL COORDINATE AND BE RESPONSIBLE FOR THE STAGING AND REMOVAL OF ALL DEMOLITION ITEMS.
- 12. THE CONTRACTOR SHALL BE RESPONSIBLE FOR REPAIRING ANY DAMAGE RESULTING FROM CONSTRUCTION ACTIVITY TO EXISTING ELEMENTS THAT ARE TO REMAIN.

EROSION NOTES

- 1. PROVIDE SILT FENCE EROSION CONTROL, IF NECESSARY.
- 2. ANY ACCIDENTAL RELEASE OF SEDIMENT FROM THE SITE SHALL BE CLEANED UP BY THE CONTRACTOR.
- 3. PRIOR TO COMPLETION OF THE PROJECT, CONTRACTOR SHALL CLEAN STREET GUTTERS WITHIN SCOPE OF WORK.
- 4. EROSION CONTROL MEASURES SHALL BE PROVIDED BY THE CONTRACTOR. CONTRACTOR TO PROVIDE LOCATION OF EROSION CONTROL METHODS FOR OWNER'S APPROVAL. PRIOR TO PROJECT

DEMOLITION AND EROSION PLAN

NOTES

- 1. REFER TO SITE PLAN SHEETS C3.2, C3.3, AND C3.4 FOR ADDITIONAL
- 2. ALL BUSINESSES AND RESIDENCES TO REMAIN OPEN, OPERABLE AND ACCESSIBLE THROUGHOUT CONSTRUCTION. TEMPORARY WALKS, BARRIERS AND DIRECTIONAL SIGNAGE TO BE INSTALLED AS NEEDED TO ASSURE SAFE VEHICULAR AND PEDESTRIAN ACCESS.
- 3. CONTRACTOR TO COMPLETE ONE BLOCK AT A TIME FROM DEMOLITION THROUGH INSTALLATION OF CURB AND SIDEWALKS. TOPSOIL AND LANDSCAPE MAY BE INSTALLED AT ONCE THROUGHOUT PROJECT.
- 4. ALL UNDERGROUND UTILITIES TO REMAIN UNLESS NOTED OTHERWISE ON THESE PLANS.
- 5. ALL UTILITIES, VALVES, METERS, FIRE HYDRANTS, THAT FALL INSIDE THE PROPOSED STREETSCAPE PROJECT ARE TO BE FLUSH WITH THE PROPOSED FINISHED GRADE.
- 6. CONTRACTOR IS RESPONSIBLE FOR COORDINATING MARKING OF THE UTILITIES WITH 'ONE-CALL' AND THE CITY OF LITTLE ROCK.
- 7. PROVIDE 36" ACCESSIBLE ROUTE AROUND SIGNAL POLES. CONTACT CITY FOR REVIEW PRIOR TO INSTALLATION OF SIDEWALKS /

LEGEND


REMOVE SIDEWALK AND √ DRIVEWAY (CONCRETE)

60% SUBMITTAL REVIEW ONLY

DRAWN BY DESIGNED SBH CHECKED SBH DATE 02-07-20 SCALE SEE PLAN PROJECT NO. 06-17-ST-267

SHEET NO.

C2.2

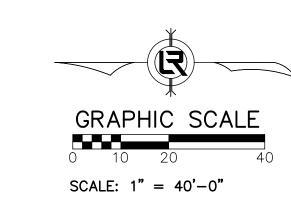



REVISIONS

ARKANSAS

CK,

RO


CITY

JOH

02-07-20 SCALE 1" = 40'-0"

PROJECT NO. 06-17-ST-267
SHEET NO. C3.1

NOTE: ABOVE SCALE REPRESENTS A PRINTED 11" X 17" SHEET SIZE.

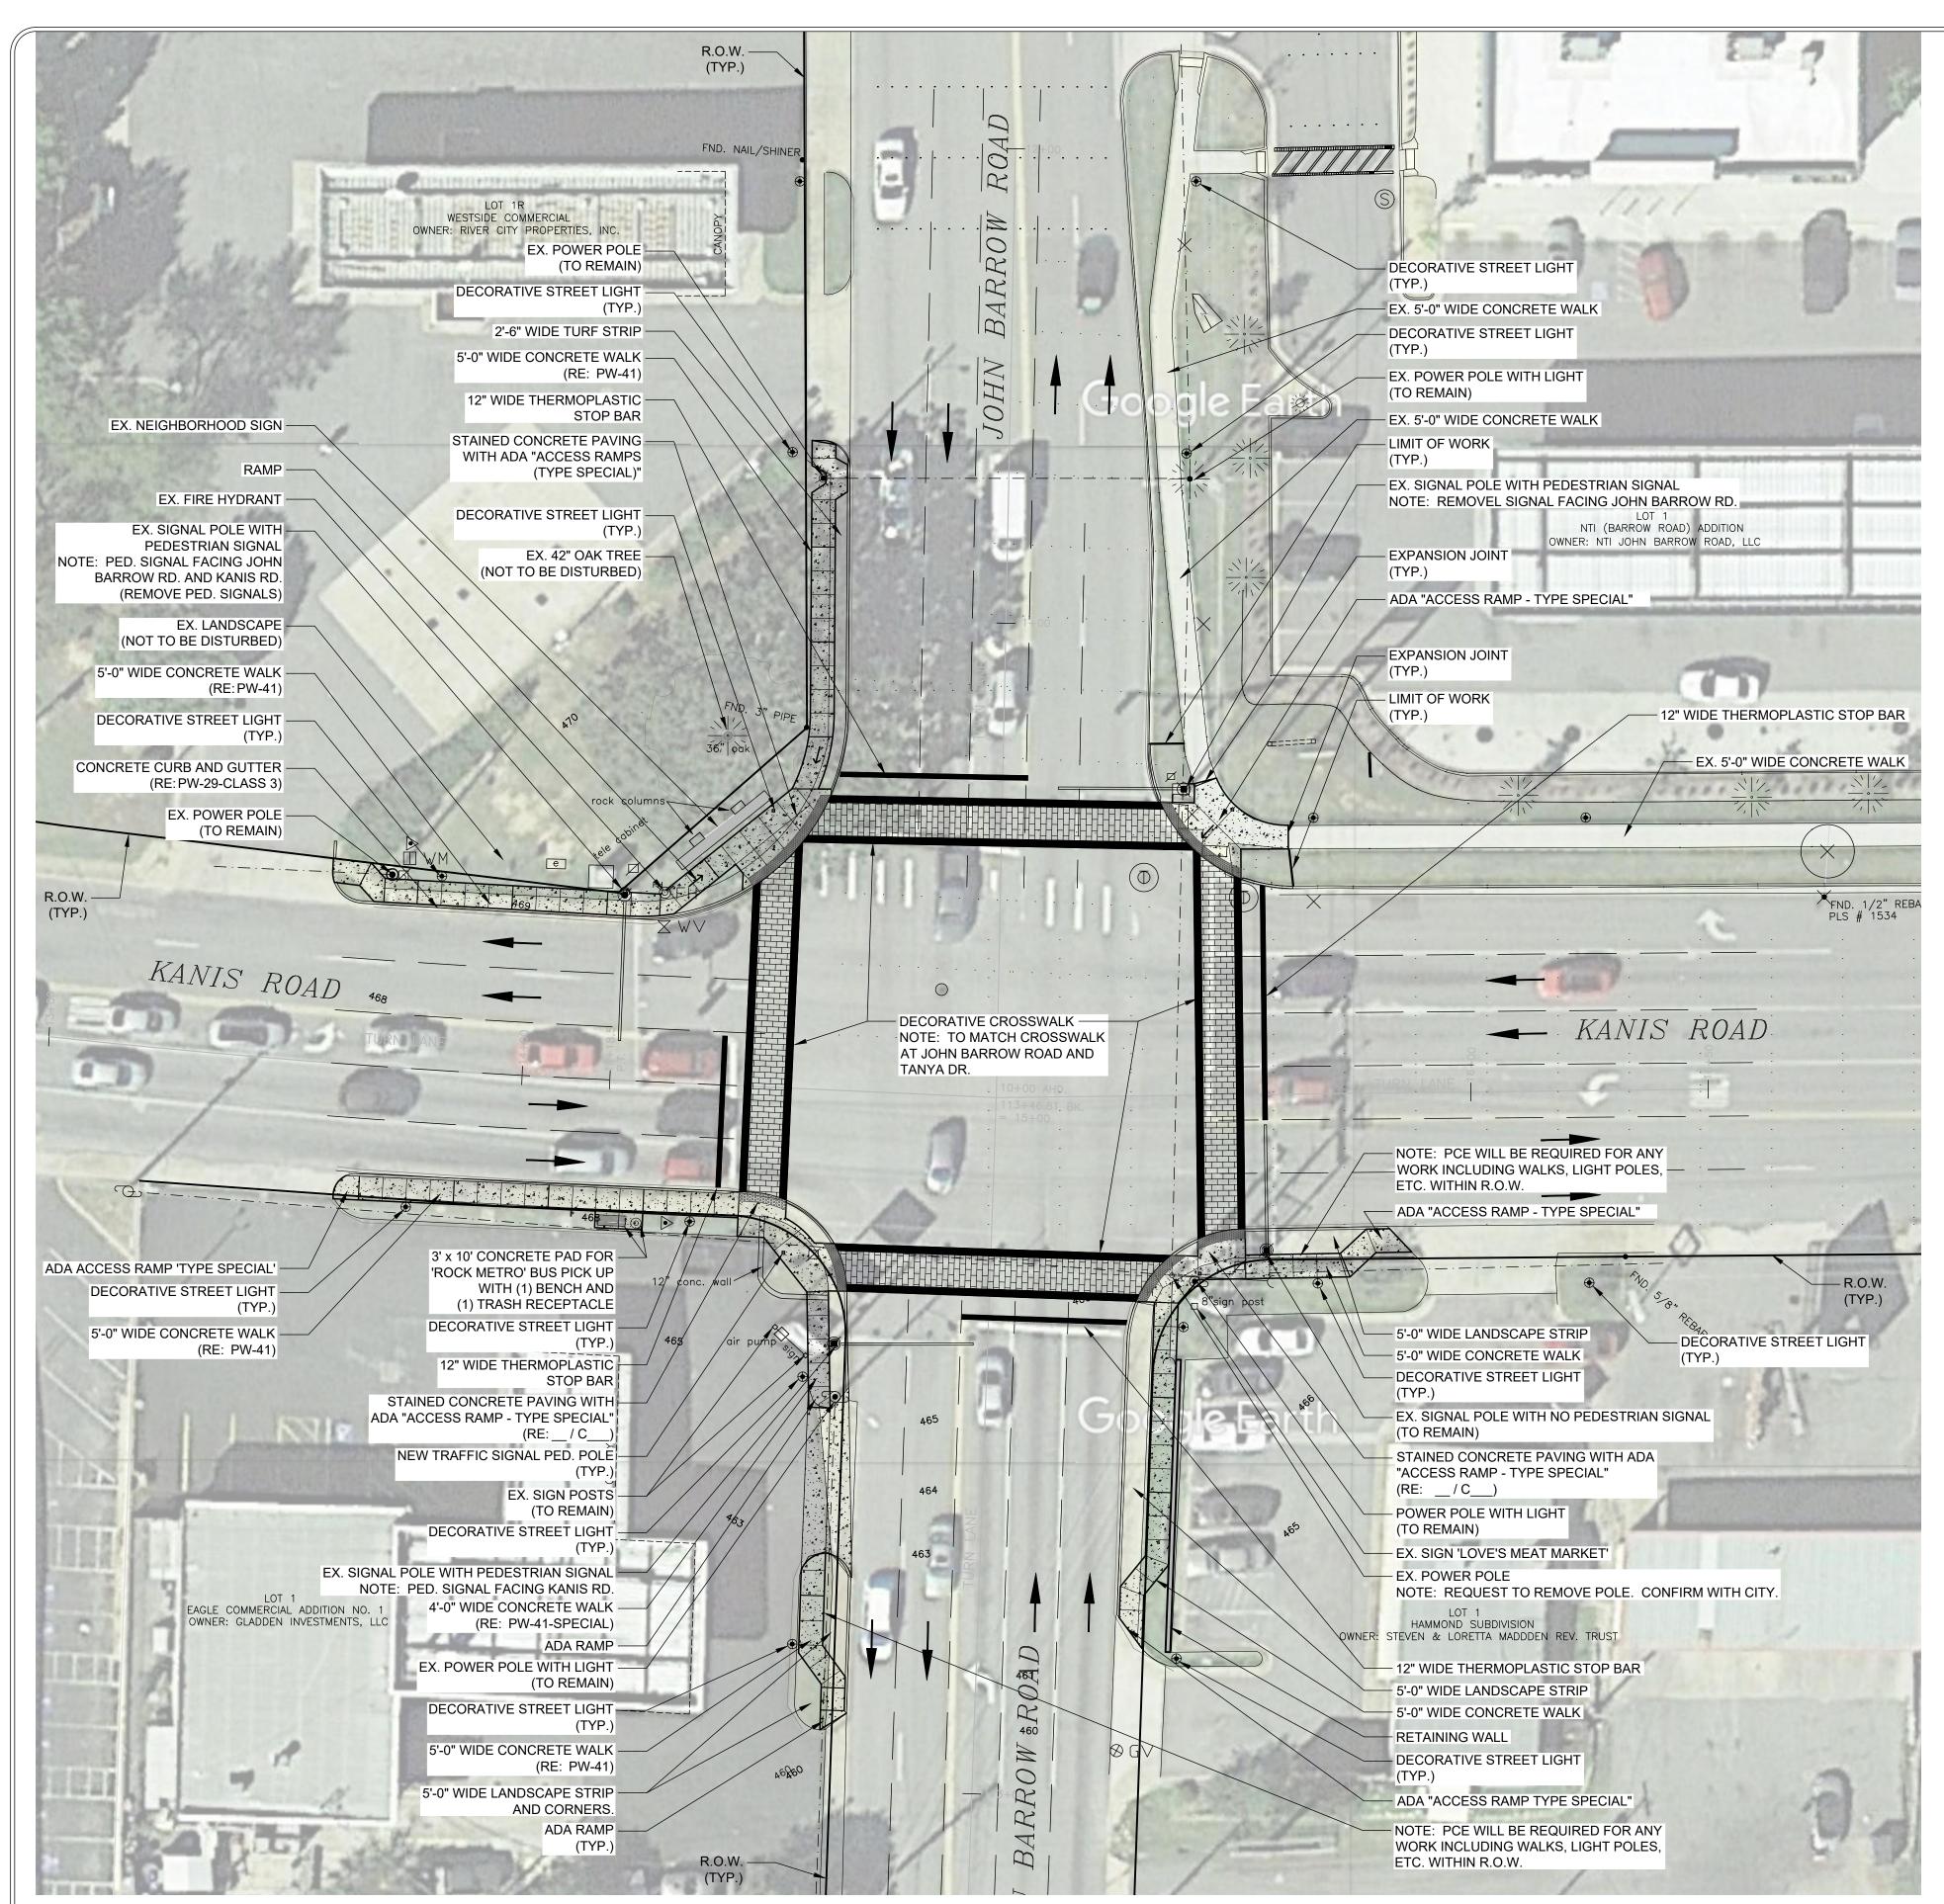


JOHN BARROW RD & KANIS RD INTERSECTION - SITE PLAN


NOTES

- 1. REFER TO SITE PLAN SHEETS C3.2 AND C3.3 FOR ADDITIONAL INFORMATION.
- 2. ALL BUSINESSES AND RESIDENCES TO REMAIN OPEN, OPERABLE AND ACCESSIBLE THROUGHOUT CONSTRUCTION. TEMPORARY WALKS, BARRIERS AND DIRECTIONAL SIGNAGE TO BE INSTALLED AS NEEDED TO ASSURE SAFE VEHICULAR AND PEDESTRIAN ACCESS.
- 3. CONTRACTOR TO COMPLETE ONE CORNER SECTION AT A TIME FROM DEMOLITION THROUGH INSTALLATION OF CURB AND SIDEWALKS. TOPSOIL AND LANDSCAPE MAY BE INSTALLED AT ONCE THROUGHOUT PROJECT.
- 4. ALL UNDERGROUND UTILITIES TO REMAIN UNLESS NOTED OTHERWISE ON THESE PLANS.
- 5. ALL UTILITIES, VALVES, METERS, FIRE HYDRANTS, THAT FALL INSIDE THE PROPOSED STREETSCAPE PROJECT ARE TO BE FLUSH WITH THE PROPOSED FINISHED GRADE.
- 6. CONTRACTOR IS RESPONSIBLE FOR COORDINATING MARKING OF THE UTILITIES WITH 'ONE-CALL' AND THE CITY OF LITTLE ROCK.
- 7. PROVIDE 36" ACCESSIBLE ROUTE AROUND SIGNAL POLES.
 CONTACT CITY FOR REVIEW PRIOR TO INSTALLATION OF SIDEWALKS /

SIDEWALK NOTES

- 1. SIDEWALK TO BE NO MORE THAN 5% LONGITUDINAL SLOPE ACROSS SLOPE 2% MAX.
- 2. BOARDWALK TO BE NO MORE THAN 5% LONGITUDINAL SLOPE ACROSS SLOPE 2% MAX.
- 3. CONTRACTOR TO PROVIDE STAKEOUT OF SIDEWALK / BOARDWALK DESIGN FOR APPROVAL PRIOR TO CONSTRUCTION.

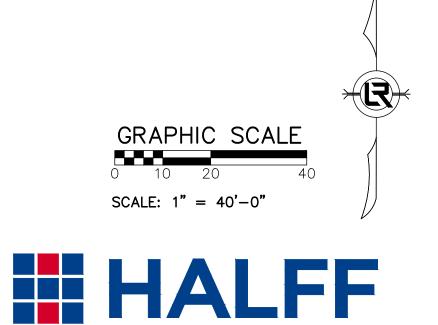

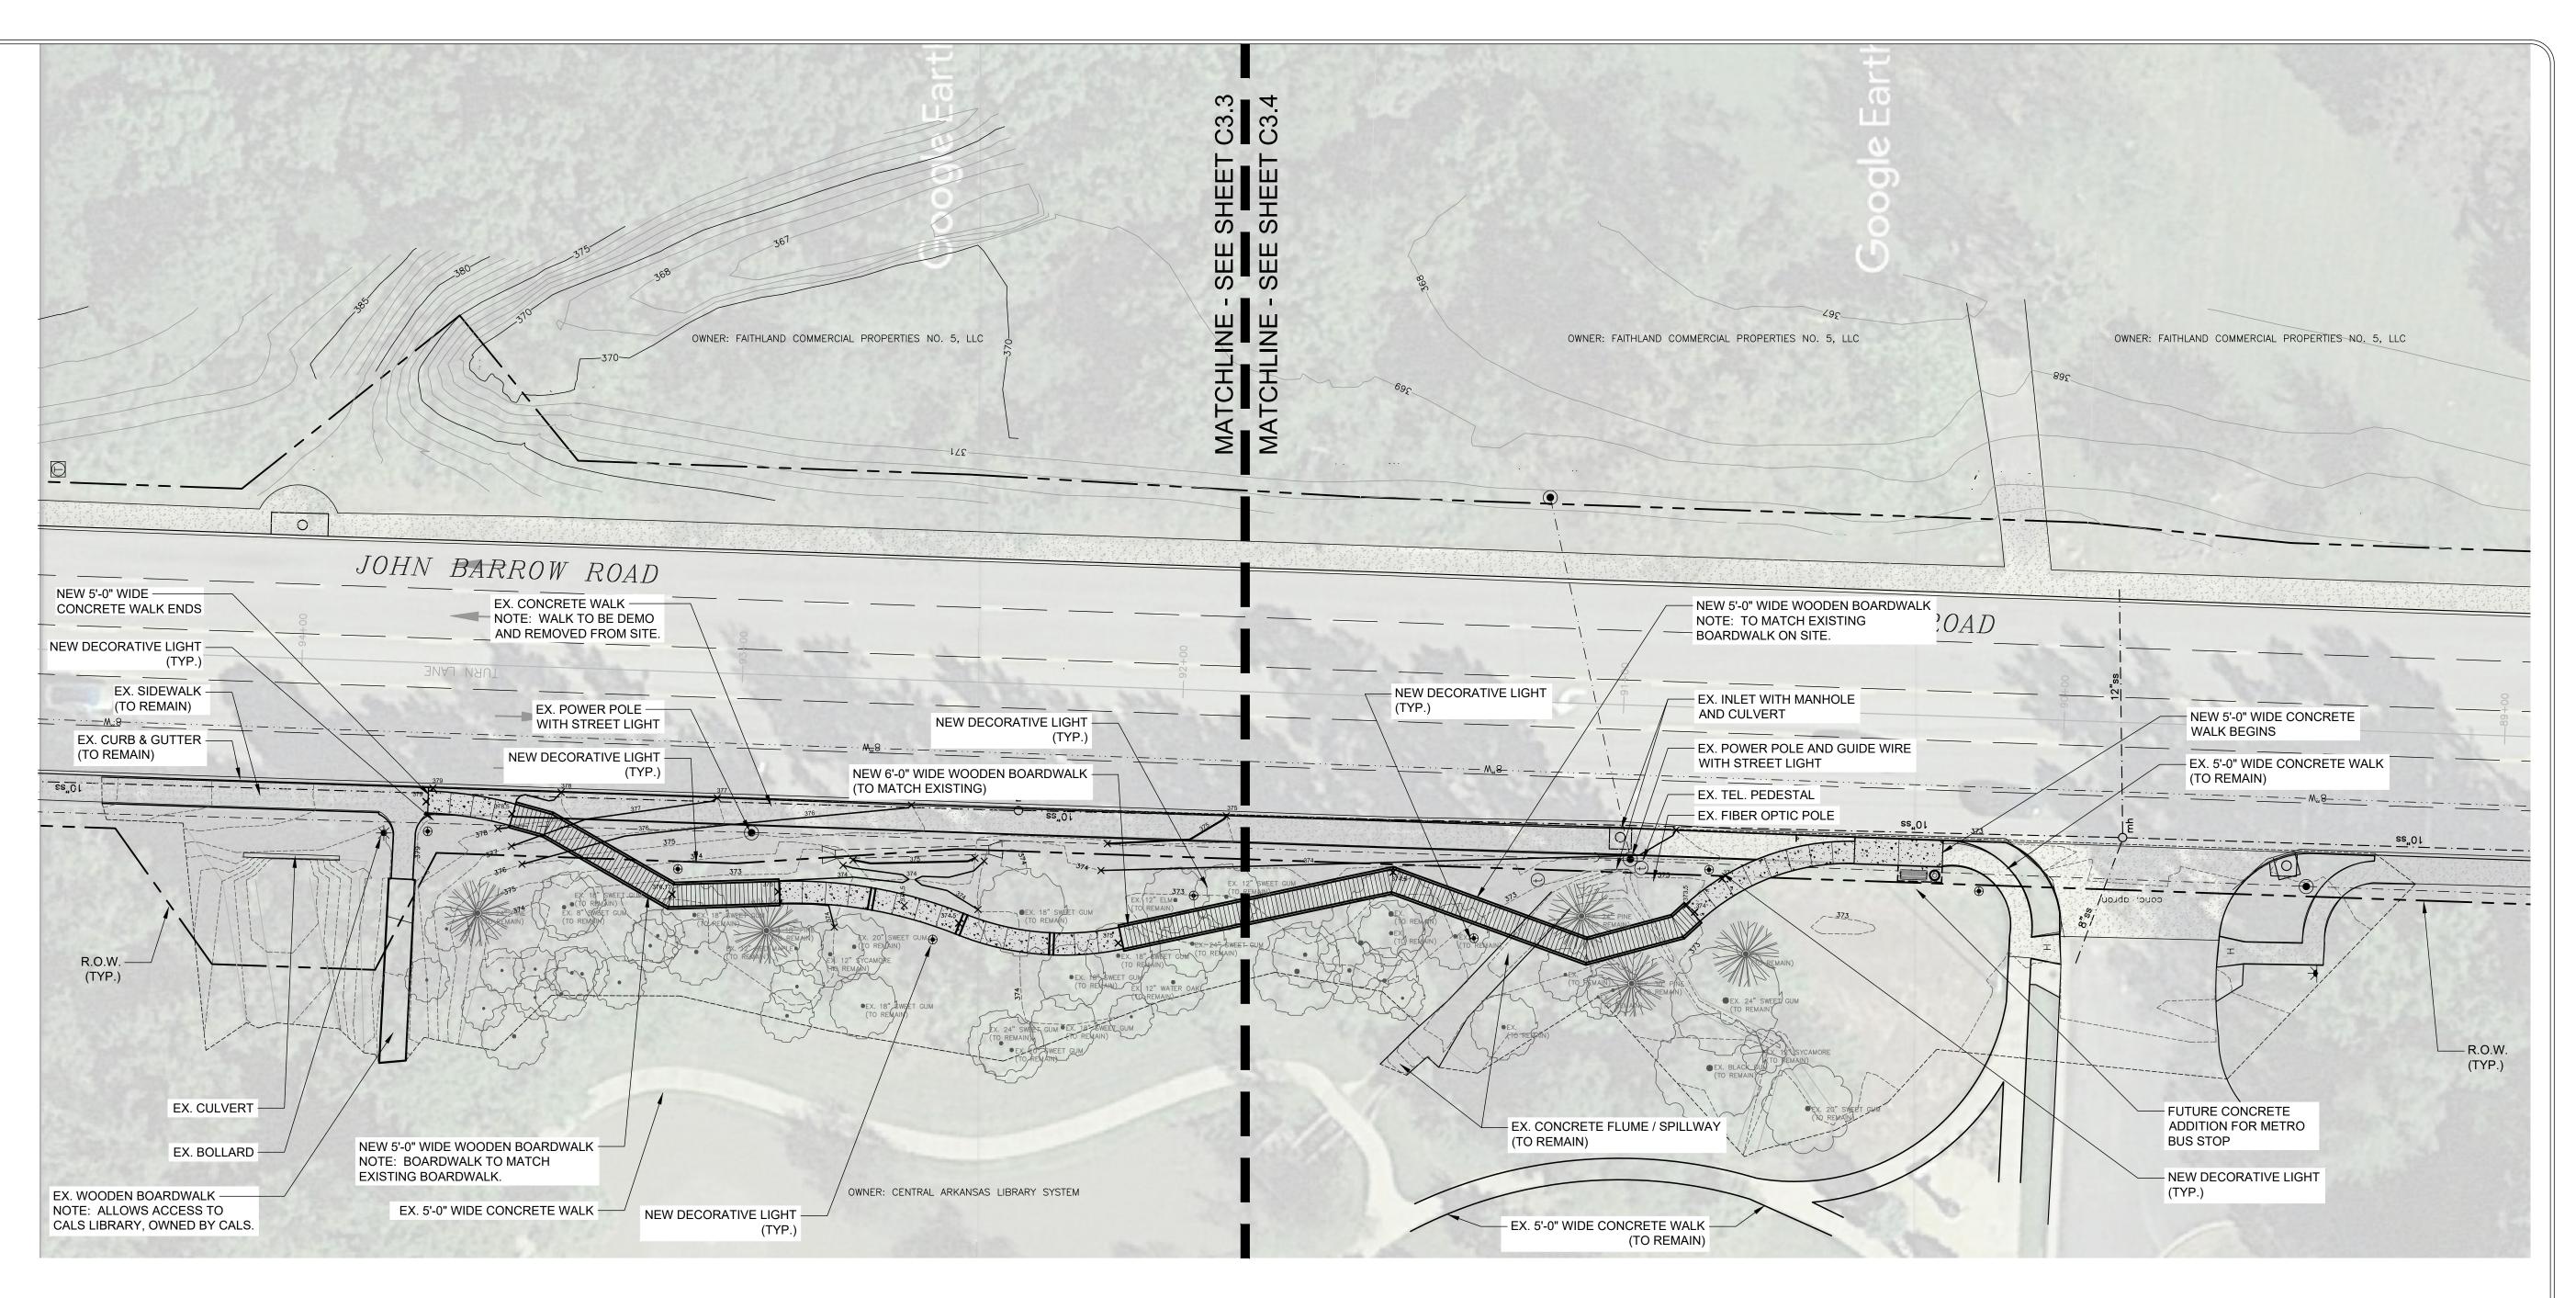

JOHN BARROW RD CALS LIBRARY BOARDWALK - SITE PLAN

NOTES

1. REFER TO SITE PLAN SHEETS C3.3 AND C3.4 FOR ADDITIONAL INFORMATION.

2. ALL UNDERGROUND UTILITIES TO REMAIN UNLESS NOTED OTHERWISE ON THESE PLANS.

3. ALL UTILITIES, VALVES, METERS, FIRE HYDRANTS, THAT FALL INSIDE THE PROPOSED STREETSCAPE PROJECT ARE TO BE FLUSH WITH THE PROPOSED FINISHED GRADE.


4. CONTRACTOR IS RESPONSIBLE FOR COORDINATING MARKING OF THE UTILITIES WITH 'ONE-CALL' AND THE CITY OF LITTLE ROCK.

SIDEWALK NOTES

1. SIDEWALK TO BE NO MORE THAN 5% LONGITUDINAL SLOPE ACROSS SLOPE 2% MAX.

2. BOARDWALK TO BE NO MORE THAN 5% LONGITUDINAL SLOPE ACROSS SLOPE 2% MAX.

3. CONTRACTOR TO PROVIDE STAKEOUT OF SIDEWALK / BOARDWALK DESIGN FOR APPROVAL PRIOR TO CONSTRUCTION.

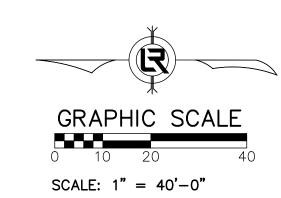



CITY O JOHN E

REVISIONS


CIVIL ENGINEERING
701 W. MARKHAM
LITTLE ROCK, ARKANSAS 72201

60% SUBMITTAL REVIEW ONLY


DRAWN BY
LCJ
DESIGNED
SBH
CHECKED
SBH
DATE
02-07-20
SCALE
1" = 40'-0"
PROJECT NO.

06-17-ST-267 SHEET NO.

C3.2

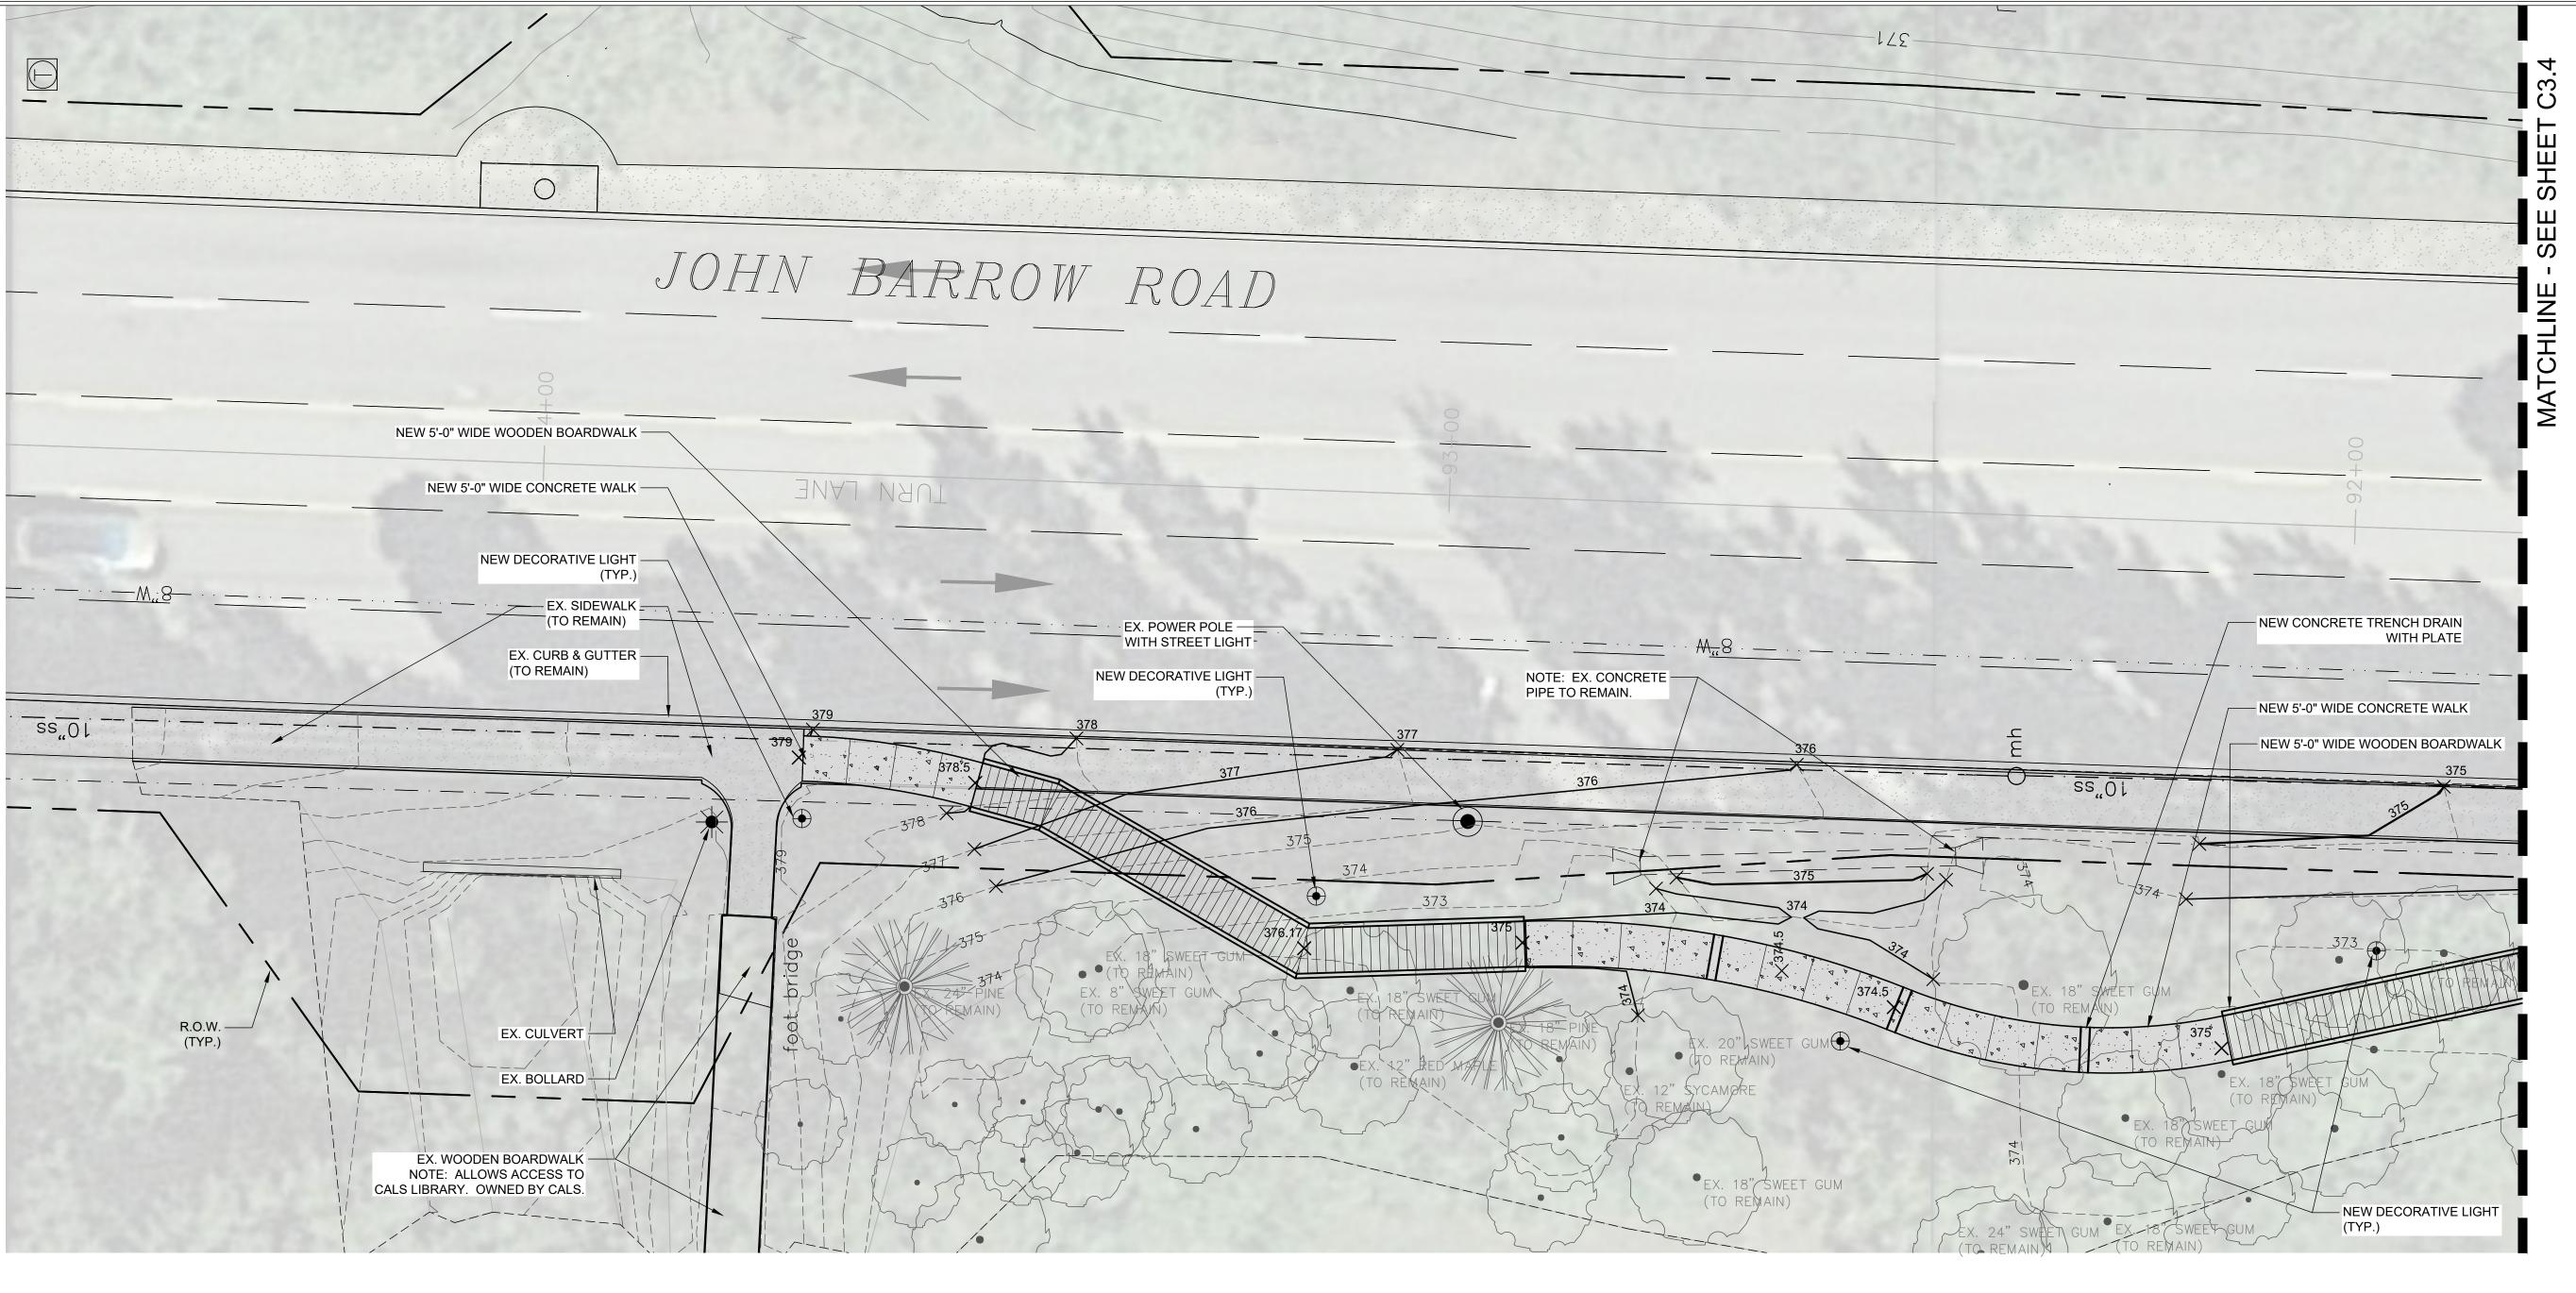

JOHN BARROW RD CALS LIBRARY BOARDWALK - ENLARGED SITE PLAN

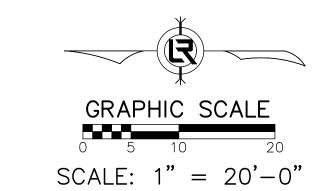



REVISIONS DATE


CITY OF LITTLE ROCK, ARKANSAS JOHN BARROW RD STREETSCAPE

CIVIL ENGINEERING
701 W. MARKHAM


60% SUBMITTAL REVIEW ONLY

DRAWN BY
LCJ
DESIGNED
SBH
CHECKED
SBH
DATE
02-07-20
SCALE
1" = 40'-0"
PROJECT N

PROJECT NO. 06-17-ST-267
SHEET NO. C3.3

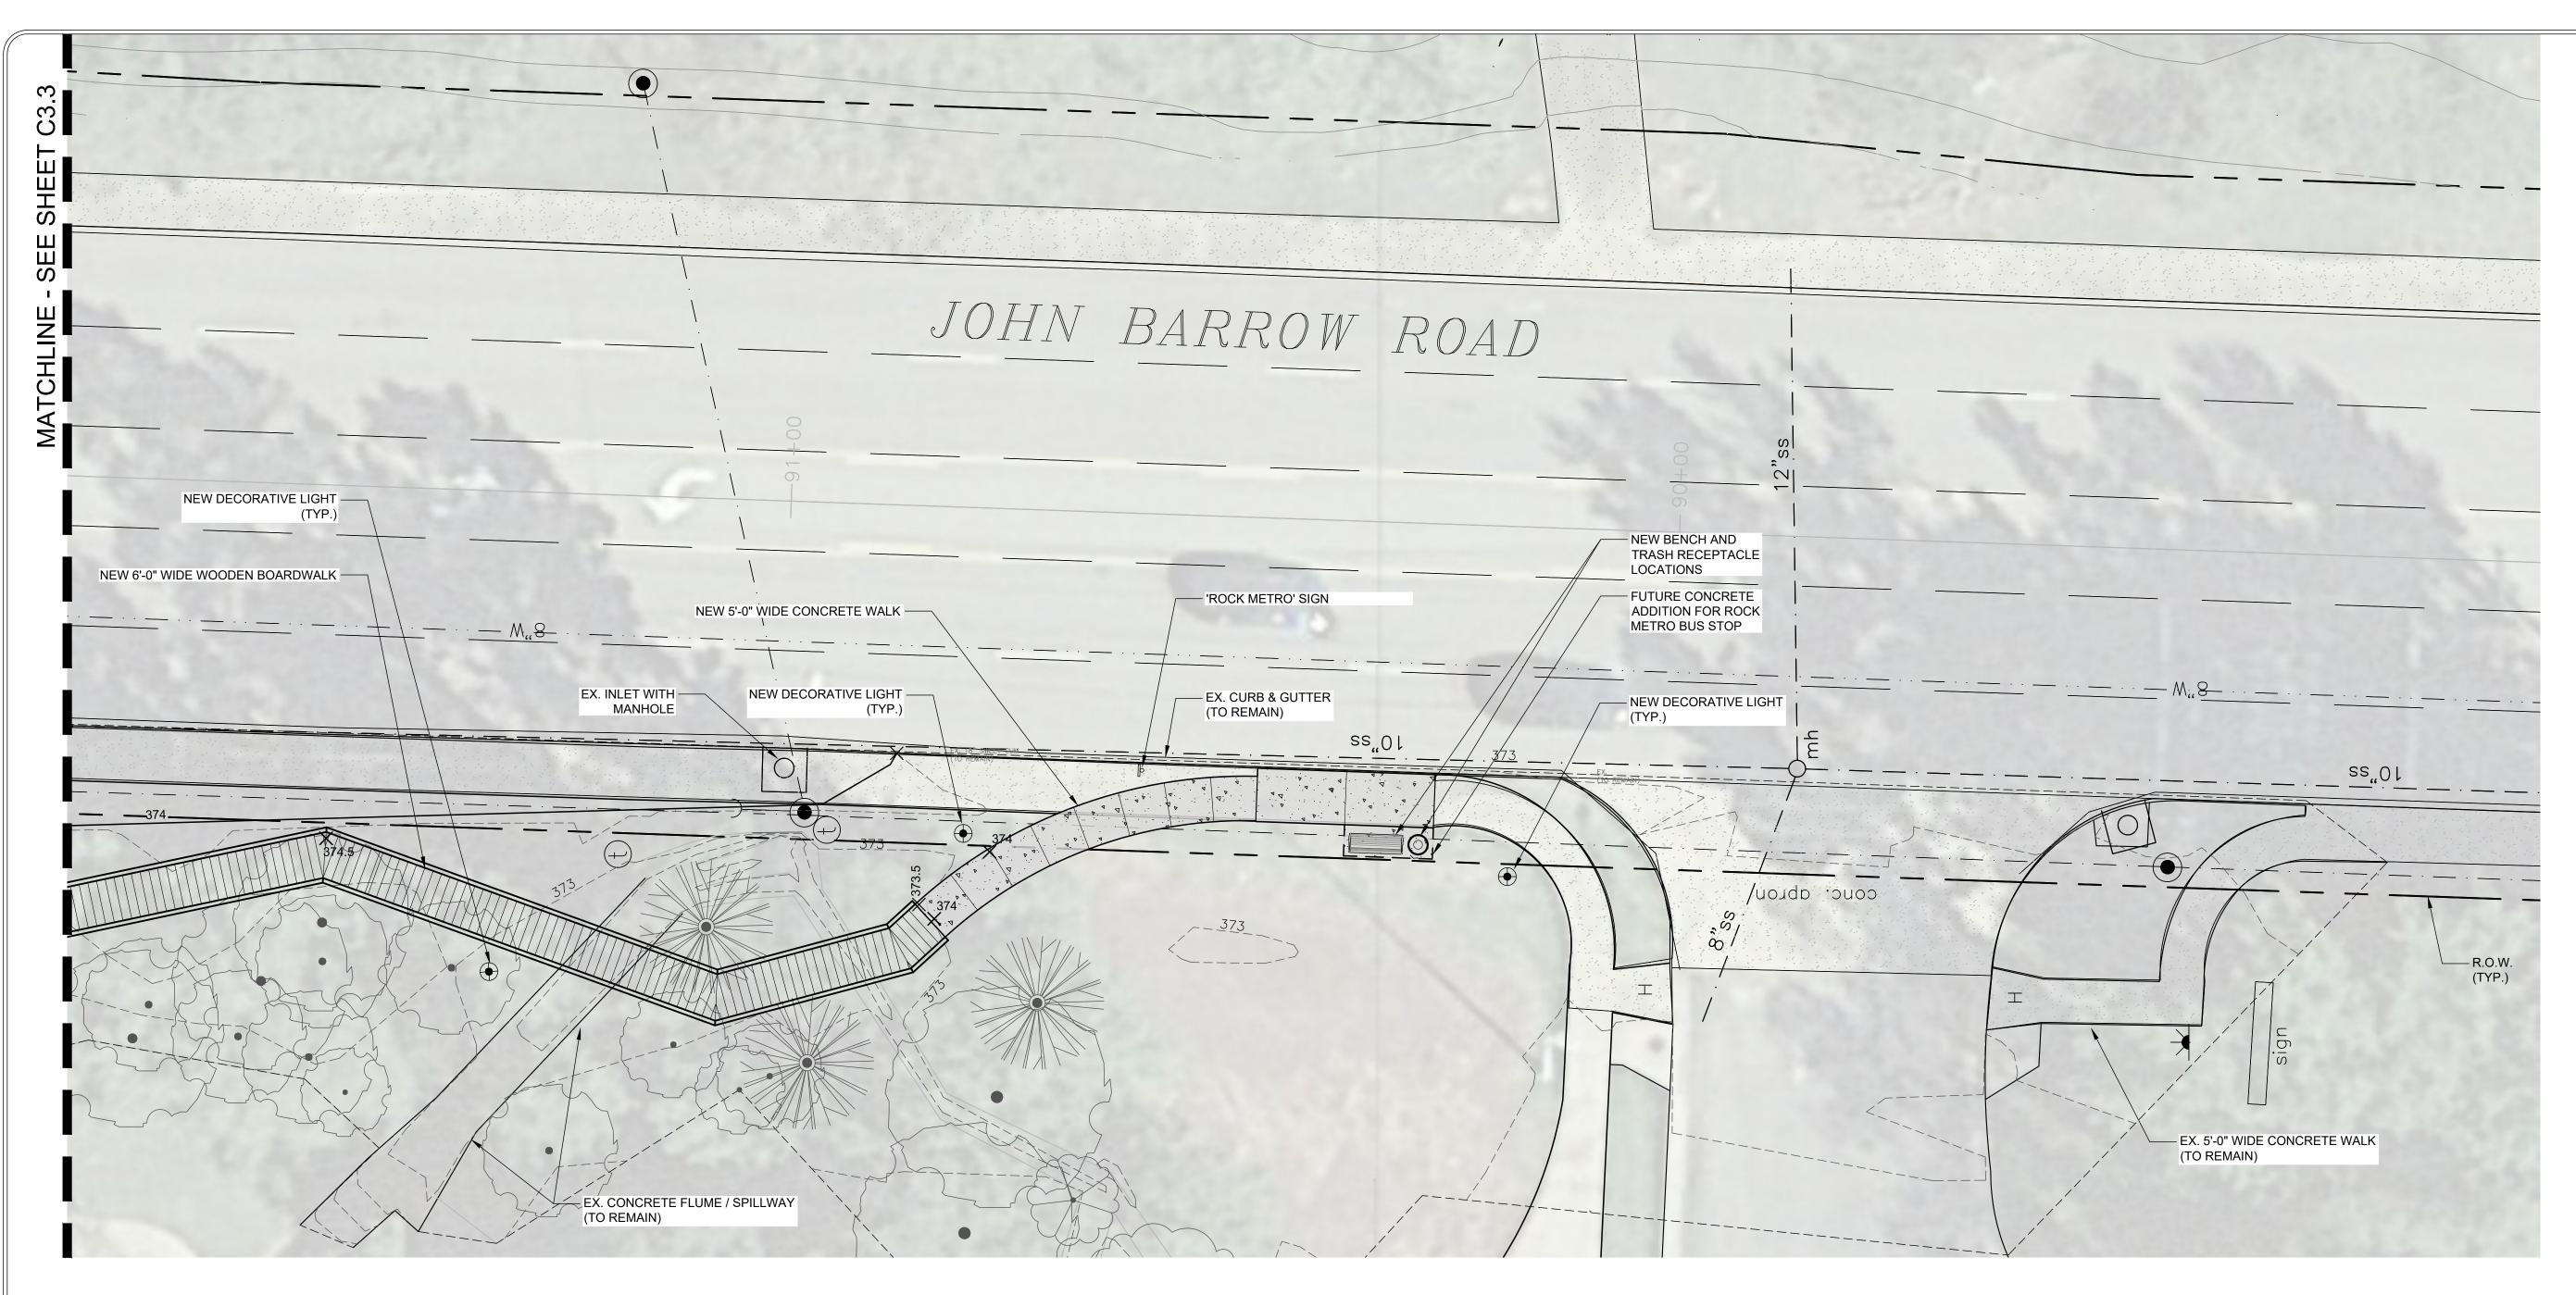

JOHN BARROW RD CALS LIBRARY BOARDWALK - ENLARGED SITE PLAN

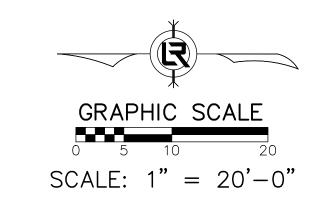



FY OF LITTLE ROCK, ARKANSAS HN BARROW RD STREETSCAPE


REVISIONS

CIVIL ENGINEERING
701 W. MARKHAM
LITTLE ROCK, ARKANSAS 7

60% SUBMITTAL REVIEW ONLY

DRAWN BY
LCJ
DESIGNED
SBH
CHECKED
SBH
DATE
02-07-20
SCALE
1" = 40'-0"
PROJECT NO.

06-17-ST-267 SHEET NO. C3.4

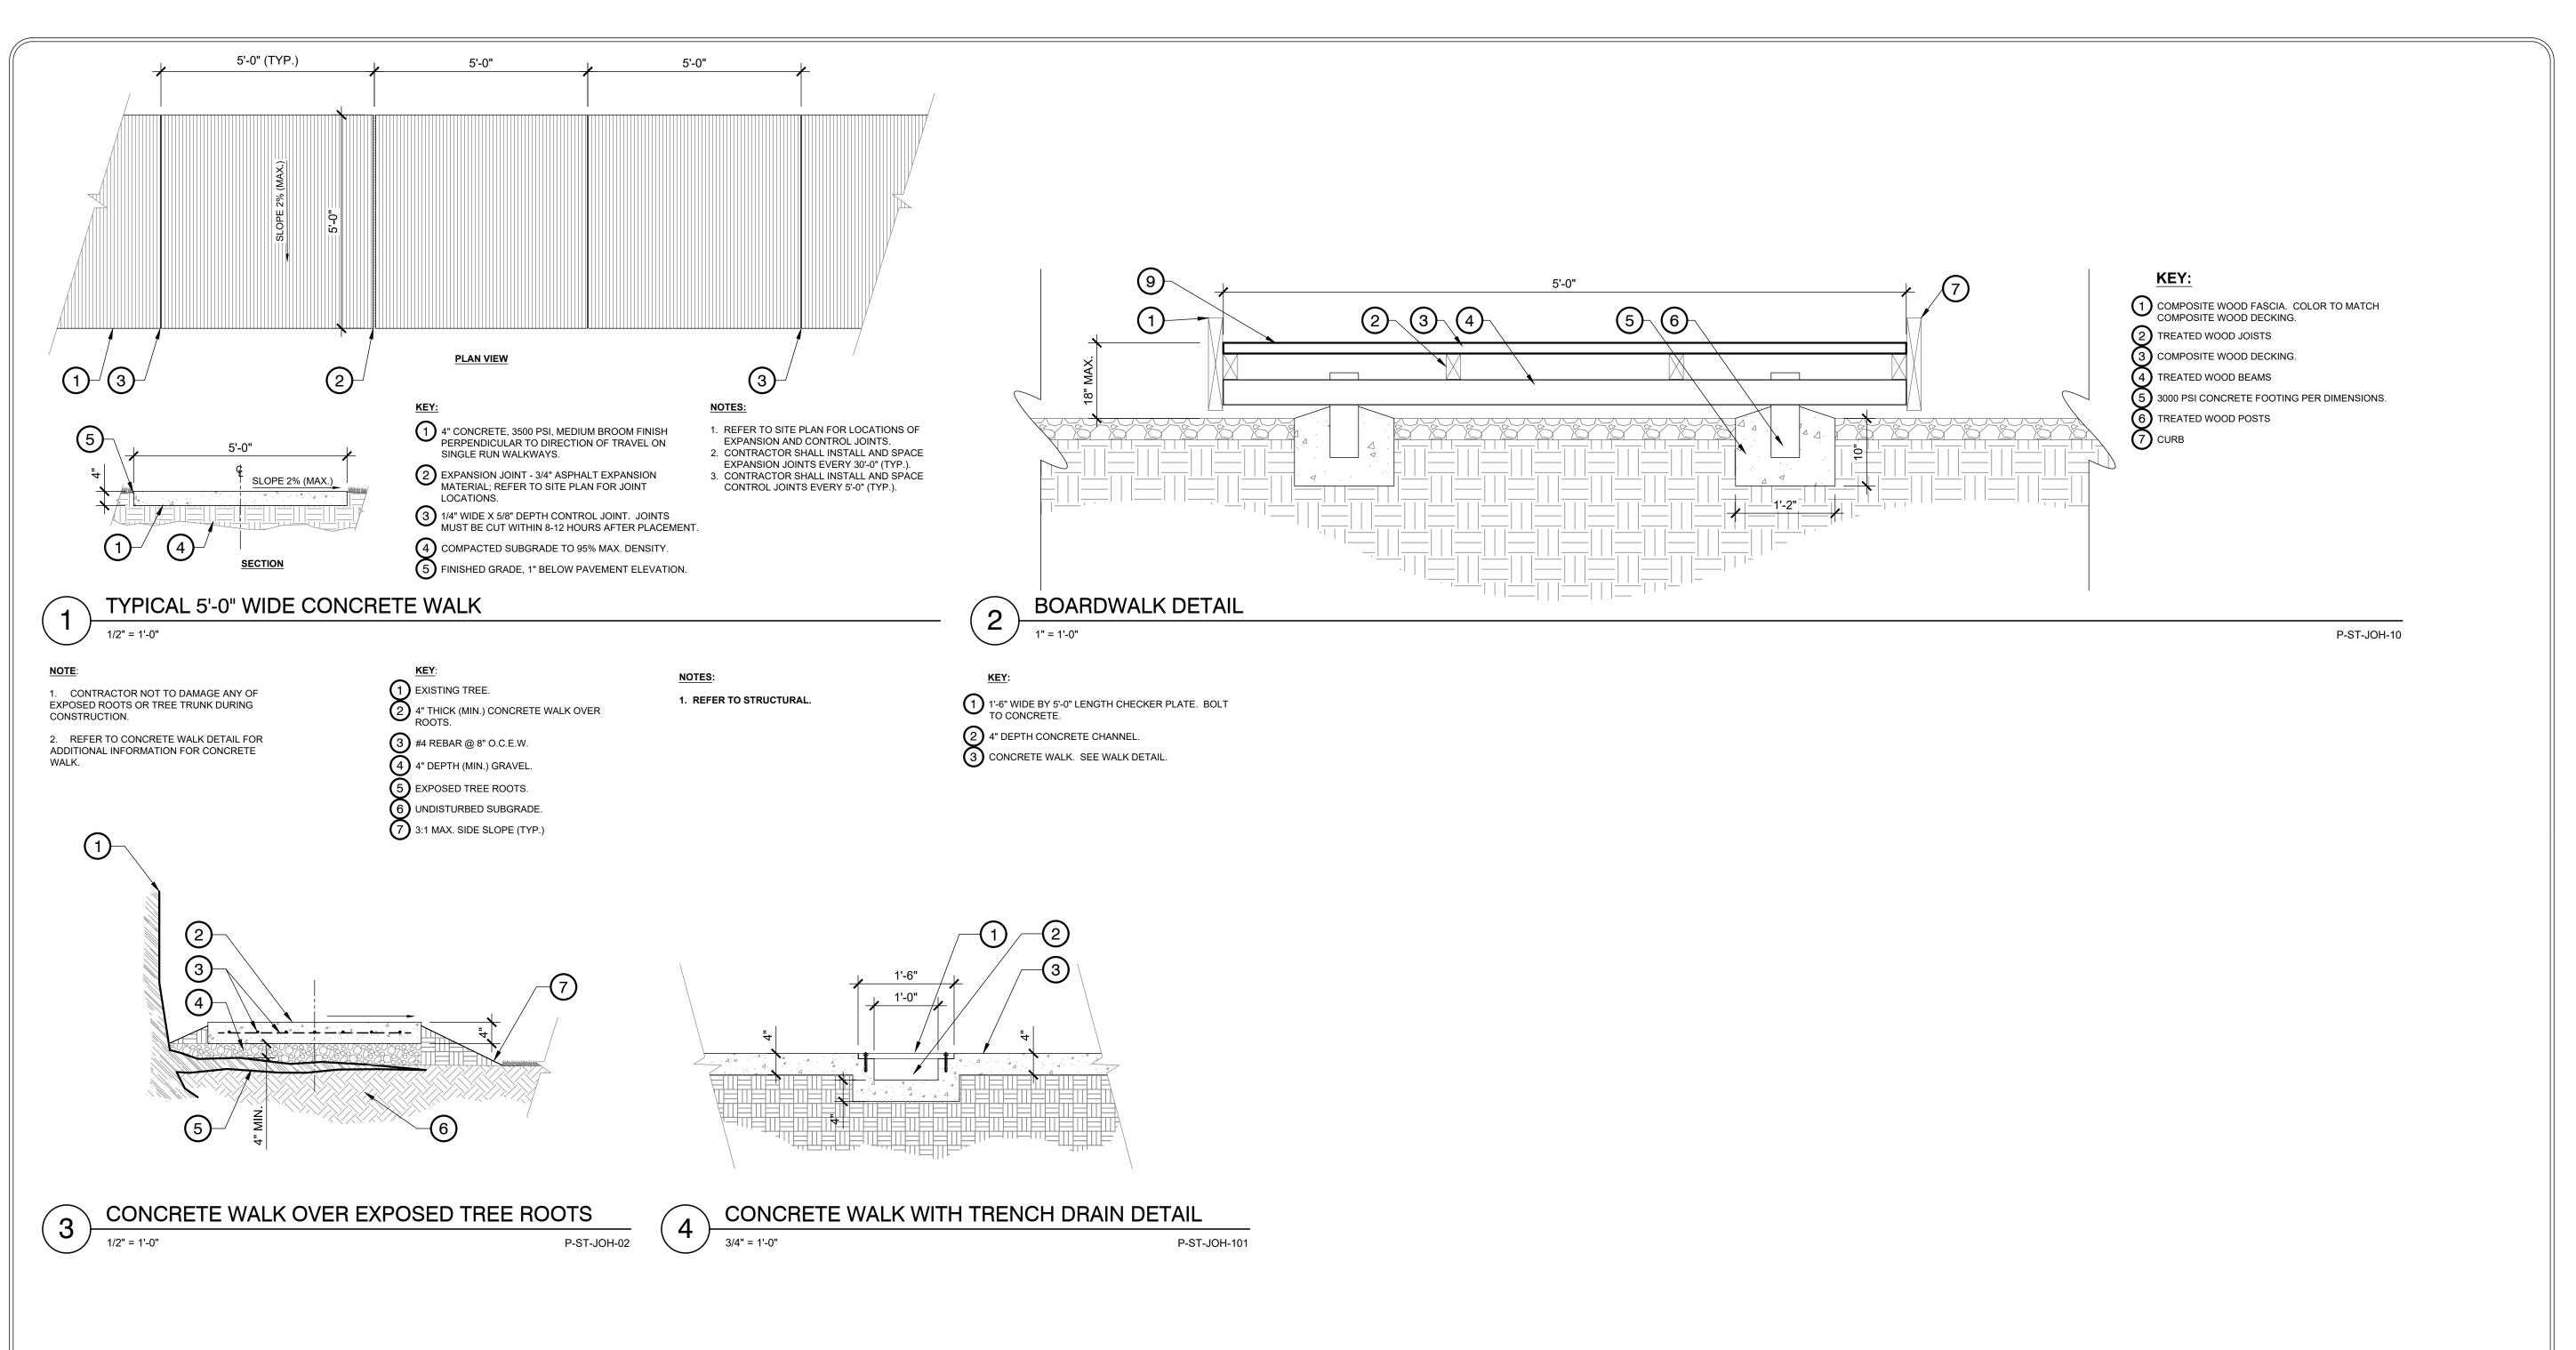



REVISIONS DATE

ARKANSAS STREETSC ROCK, RD

OF

CITY

JOHN

60% SUBMITTAL REVIEW ONLY

DRAWN BY LCJ DESIGNED SBH CHECKED SBH DATE 02-07-20 SCALE

PROJECT NO. 06-17-ST-267 SHEET NO.

C4.1